## SITE SPECIFIC DATA REQUIREMENTS STRUCTURE ID WATER QUALITY FLOW RATE (L/S) PEAK FLOW RATE (L/S) RETURN PERIOD OF PEAK FLOW (yrs) # OF CARTRIDGES REQUIRED (8-22) CARTRIDGE HEIGHT (310, 460 or 690mm) 460 MEDIA TYPE (PERLITE, PERLITE/ZEOLITE OR ZPG) ZPG PRECAST VAULT WEIGHT 2524 kg PRECAST LID WEIGHT 547 kg PIPE DATA: MATERIAL DIAMETER INLET PIPE #1 20.53 150 INLET PIPE #2 20.53 150 INLET PIPE #3 | 20.53 PVC 150 OUTLET PIPE 20.42 PVC 225 PIPE ORIENTATION DOWNSTREAM UPSTREAM FLOW **FLOW** LADDER YES/NO ANTI-FLOTATION BALLAST N/A N/A N/A

## STORMFILTER TABLE

N.T.S.

## **GENERAL NOTES**

- INLET AND OUTLET PIPING SHALL BE SPECIFIED BY SITE CIVIL ENGINEER (SEE PLANS) AND PROVIDED BY CONTRACTOR. STORMFILTER IS PROVIDED WITH OPENINGS

  AT AND OUTLET LOCATIONS.
- AT INLET AND OUTLET LOCATIONS.

  2. IF THE PEAK FLOW RATE, AS DETERMINED BY THE SITE CIVIL ENGINEER, EXCEEDS THE PEAK HYDRAULIC CAPACITY OF THE PRODUCT, AN UPSTREAM BYPASS STRUCTURE IS REQUIRED.
- PLEASE CONTACT STORMWATER360 FOR OPTIONS.

  3. THE FILTER CARTRIDGE(S) ARE SIPHON-ACTUATED AND SELF-CLEANING. THE STANDARD DETAIL DRAWING SHOWS THE MAXIMUM NUMBER OF CARTRIDGES. THE ACTUAL NUMBER SHALL BE SPECIFIED BY THE SITE CIVIL ENGINEER ON SITE PLANS OR IN DATA TABLE BELOW. PRECAST STRUCTURE TO BE CONSTRUCTED IN ACCORDANCE WITH AS3600.
- 4. FOR SHALLOW, LOW DROP OR SPECIAL DESIGN CONSTRAINTS, CONTACT STORMWATER360 FOR DESIGN OPTIONS.
- 5. ALL WATER QUALITY PRODUCTS REQUIRE PERIODIC MAINTENANCE AS OUTLINED IN THE O&M GUIDELINES. PROVIDE MINIMUM CLEARANCE FOR MAINTENANCE ACCESS.
- 6. STRUCTURE AND ACCESS COVERS DESIGNED TO MEET AUSTROADS T44 LOAD RATING WITH 0-2m FILL MAXIMUM.
- 7. THE STRUCTURE THICKNESSES SHOWN ARE FOR
- REPRESENTATIONAL PURPOSES AND VARY REGIONALLY.

  8. ANY BACKFILL DEPTH, SUB-BASE, AND OR ANTI-FLOTATION PROVISIONS ARE SITE-SPECIFIC DESIGN CONSIDERATIONS AND
- SHALL BE SPECIFIED BY SITE CIVIL ENGINEER.

  9.. STORMFILTER BY STORMWATER360:
  SYDNEY (AU) PHONE: (02) 9525 5833,
  BRISBANE (AU) PHONE: (07) 3272 1872.


## STORMFILTER DESIGN TABLE


- STORMFILTER TREATMENT CAPACITY VARIES BY NUMBER OF FILTER CARTRIDGES INSTALLED AND
- BY REGION SPECIFIC INTERNAL FLOW CONTROLS. CONVEYANCE CAPACITY IS RATED AT 80L/S.

   THE STANDARD CONFIGURATION IS SHOWN. ACTUAL CONFIGURATION OF THE SPECIFIED
- THE STANDARD CONFIGURATION IS SHOWN. ACTUAL CONFIGURATION OF THE SPEC STRUCTURE(S) PER CIVIL ENGINEER WILL BE SHOWN ON SUBMITTAL DRAWING(S).
- ALL PARTS PROVIDED AND INTERNAL ASSEMBLY BY STORMWATER360 AUSTRALIA UNLESS
- OTHERWISE NOTED.

CARTRIDGE HEIGHT	690		460		310	
SYSTEM HYDRAULIC DROP (H - REQ'D. MIN.)	930		700		550	
TREATMENT BY MEDIA SURFACE AREA L/S/m2	1.4	0.7	1.4	0.7	1.4	0.7
CARTRIDGE FLOW RATE (L/s)	1.42	0.71	0.95	0.47	0.63	0.32

SYSTEM HYDRAULIC DROP CARTRIDGE FLOW RATE

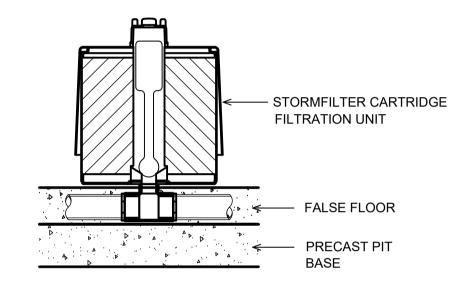

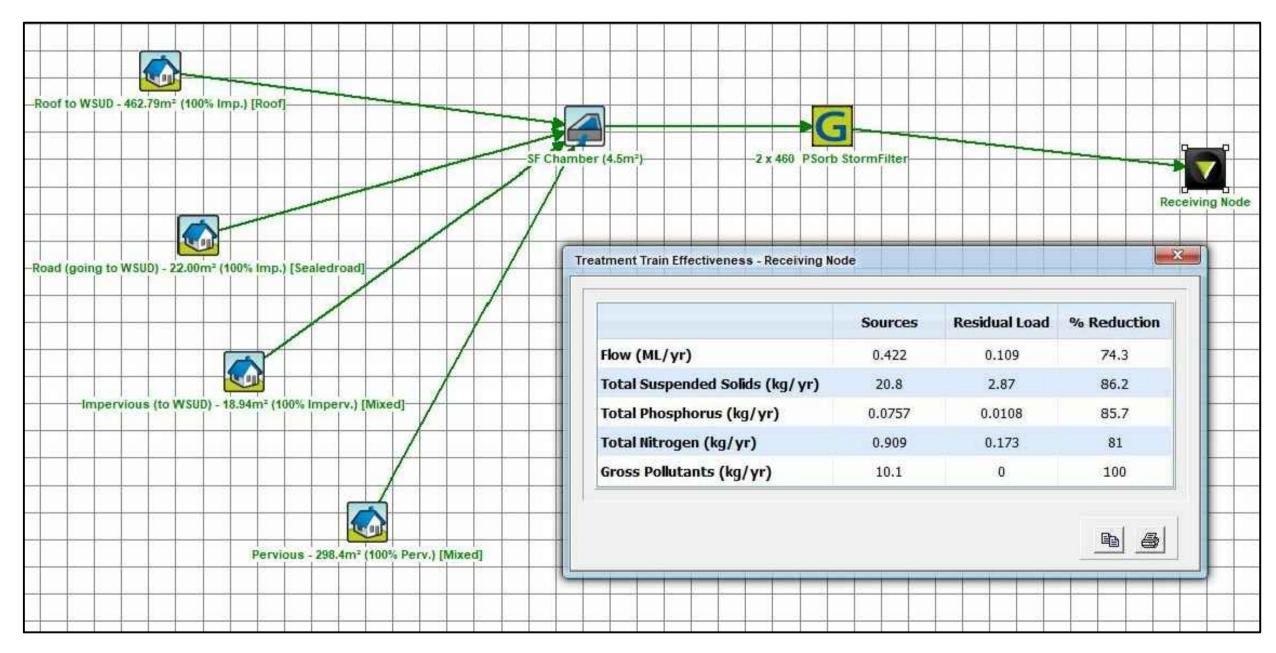

WSUD RESULTS

N.T.S.

NOT FOR CONSTRUCTION

				Alo	Idraft Architecs Pty Ltd Unit 43,2 Slough Avenue, Silverwater NSW 2128	Liverpool City Council	Scale  0 200 400 600mm  SCALE 1:10 @ A1	I VENGINEERS.	Project 23 - 25 CHARLES STREET, LIVERPO PROPOSED MULTI-UNIT DEVELOPM
	A ISSUE FOR DEVELOPMENT APPLICATION	09/12/2020	0 AGA JSF	April would	PHONE : 02 9648 8848	Torry Courton	0 0.2 0.4 0.6 0.8 1.0 1.2m	AUSTRALIAN PTY LTD - A.C.N. 084 059 941	STORMWATER CONCEPT PLAN
Is	Description  1cm at full, size , 10cm	Date	Design Checked	( ASSEM)	Email :pierre@idraft.com.au www.idraft.com.au		SCALE 1:25 @ A1	CONSULTING LEVEL 4, 470 CHURCH STREET NORTH PARRAMATTA NSW 2150 PH: (02) 9763 1500 FX: (02) 9763 1515 ENGINEERS. EMAIL: info@aceeng.com.au	DEVELOPMENT APPLICATION

POOL ON-SITE DETENTION DETAILS AND CALCULATION SHEETS SHEET 2 OF 2

Scale A1 Project No. Dwg. No. Issu
As Shown 200977 103